



FOR RIDOH USE ONLY	
PWS ID #	_____
SDWIS WELL ID #	_____

1. WELL LOCATION GPS (Required in WGS84 degrees, decimal degree format) N 41.2354° W 71.3258°
 Address at Well Location 2625B Commodore Perry Hwy Property Owner Ames Kaiser
 Subdivision/Property Description _____ Engineering Firm _____
 City/Town South Kingstown, RI Mailing Address 37 Flagg Lane
 Assessors Map _____ Assessor's Lot # _____ City/Town N. Kingstown, RI State RI

[PUBLIC WELLS ONLY] RIDOH Well Location Approval Issued on Date: _____ Please attach completed Source Well Data Form.

2. WORK PERFORMED	3. WELL TYPE	4. METHOD	6. ADDITIONAL WELL INFORMATION
<u>NN</u>	<u>PRIV DMST</u> <input type="checkbox"/> Overburden <input checked="" type="checkbox"/> Bedrock	<u>AH</u>	Developed <input type="checkbox"/> Y <input type="checkbox"/> N Fracture Enhancement <input type="checkbox"/> Y <input type="checkbox"/> N Disinfected <input type="checkbox"/> Y <input type="checkbox"/> N Depth to Bedrock <u>135</u> ft BGS Total Well Depth <u>505</u> ft BGS

5. WELL LOG		OVERBURDEN			Drop in Drill Stem	Extra Fast or Slow Drill Rate	Loss or Addition of Fluid
From (ft)	To (ft)	Code	Color	Comment			
<u>0</u>	<u>135</u>	<u>GR</u>	<u>BR</u>		<input type="checkbox"/> Y <input type="checkbox"/> N <input type="checkbox"/> F <input type="checkbox"/> S <input type="checkbox"/> L <input type="checkbox"/> A		
					<input type="checkbox"/> Y <input type="checkbox"/> N <input type="checkbox"/> F <input type="checkbox"/> S <input type="checkbox"/> L <input type="checkbox"/> A		
					<input type="checkbox"/> Y <input type="checkbox"/> N <input type="checkbox"/> F <input type="checkbox"/> S <input type="checkbox"/> L <input type="checkbox"/> A		
					<input type="checkbox"/> Y <input type="checkbox"/> N <input type="checkbox"/> F <input type="checkbox"/> S <input type="checkbox"/> L <input type="checkbox"/> A		
					<input type="checkbox"/> Y <input type="checkbox"/> N <input type="checkbox"/> F <input type="checkbox"/> S <input type="checkbox"/> L <input type="checkbox"/> A		

7. CASING / LINER					Top of Casing _____ in. AGS	
From (ft BGS)	To (ft BGS)	Type	Thickness	Diameter		
<u>0</u>	<u>185</u>	<u>STL</u>	<u>17</u>	<u>10 5/8</u>		

5. WELL LOG		BEDROCK			Drop in Drill Stem	Extra Large Chips	Extra Fast or Slow Drill Rate	Visible Rust Staining
From (ft)	To (ft)	Code	Comment					
<u>135</u>	<u>505</u>	<u>GR</u>		<input type="checkbox"/> Y <input type="checkbox"/> N <input type="checkbox"/> Y <input type="checkbox"/> N <input type="checkbox"/> F <input type="checkbox"/> S <input type="checkbox"/> Y <input type="checkbox"/> N				
				<input type="checkbox"/> Y <input type="checkbox"/> N <input type="checkbox"/> Y <input type="checkbox"/> N <input type="checkbox"/> F <input type="checkbox"/> S <input type="checkbox"/> Y <input type="checkbox"/> N				
				<input type="checkbox"/> Y <input type="checkbox"/> N <input type="checkbox"/> Y <input type="checkbox"/> N <input type="checkbox"/> F <input type="checkbox"/> S <input type="checkbox"/> Y <input type="checkbox"/> N				
				<input type="checkbox"/> Y <input type="checkbox"/> N <input type="checkbox"/> Y <input type="checkbox"/> N <input type="checkbox"/> F <input type="checkbox"/> S <input type="checkbox"/> Y <input type="checkbox"/> N				
				<input type="checkbox"/> Y <input type="checkbox"/> N <input type="checkbox"/> Y <input type="checkbox"/> N <input type="checkbox"/> F <input type="checkbox"/> S <input type="checkbox"/> Y <input type="checkbox"/> N				

8. SCREEN					Manufacturer:	
From	To	Type	Slot Size	Diameter		

9. WATER-BEARING ZONES		
From (ft BGS)	To (ft BGS)	Cumulative Blow Test Yield (GPM)
<u>425</u>	<u>427</u>	<u>5</u>

10. PERMANENT PUMP Variable Constant
 Description Franklin 4100 200 HP RPM
 Intake Depth 475 ft BGS Nominal Capacity _____ GPM

11. FILTER PACK / ANNULAR SEAL								
	From	To	Material 1	Weight	Material 2	Weight	Water (gal)	Method of Placement
Pack	<u>0</u>	<u>165</u>	<u>CB</u>					
Seal								

12. BORE HOLE		
Dia.	From (ft BGS)	To (ft BGS)
<u>8 3/4</u>	<u>0</u>	<u>165</u>
<u>6</u>	<u>165</u>	<u>505</u>

Explosives used: Y Type: _____ Amount: _____

13. STATIC WATER LEVEL		14. WELL TEST DATA (Private Wells only. Public Water Systems must submit full report.)							
Date Measured	Static Depth (ft BGS)	Date	Yield (GPM)	Time Pumped (hrs)	(min)	Total Drawdown (ft BGS)	Time to Recover (hrs)	(min)	Depth at Recovery

15. COMMENTS _____

16. WELL DRILLER STATEMENT This well was drilled or altered under my direct supervision, according to the applicable rules and regulations, and this report is complete and accurate to the best of my knowledge.

Driller [Signature] Supervising Driller Signature [Signature] Registration # _____
 Company Ace Well Drilling Start Date _____ Date Work Completed 2/14/2024



LOCUS MAP

LOT 13 SCALE
 BEING MAP 8003 LOT 14
 LOT AREA = 2.84 AC.

FEAS. DETERMINATION
 PANEL 1-C - 440000384
 EFFECTIVE: OCTOBER 18, 2013

PARCEL ZONING: R80
 MIN. LOT SIZE = 80,000 S.F.
 MIN. LOT FRONTAGE = 200'
 MIN. FRONT YARD SETBACK = 50'
 REAR SETBACK = 50'
 SIDE SETBACK = 40'
 MAX. LOT BUILDING COVERAGE = 20%

AVAILABLE PARKING
 (FOR 18) IF PARKING SPACES
 AVAILABLE

REFERENCES:
 1. THE PLAN IS BASED ON THE DATA PROVIDED BY THE CLIENT. THE CLIENT HAS REPRESENTED THAT THE DATA IS TRUE AND CORRECT AND HAS NOT BEEN FIELD VERIFIED.
 2. THE PROPERTY LINE SHOWN WAS TAKEN FROM A TITLE REPORT AND IS SUBJECT TO THE RESTRICTIONS, COMMENTS, AND/OR EASEMENTS THAT MAY BE CONTAINED THEREIN.
 3. THE PLAN IS BASED ON THE DATA PROVIDED BY THE CLIENT. THE CLIENT HAS REPRESENTED THAT THE DATA IS TRUE AND CORRECT AND HAS NOT BEEN FIELD VERIFIED. CONTACT US PRIOR TO ANY OCCUPATION.

NOTES:
 1. THE PROPERTY LINE SHOWN WAS TAKEN FROM A TITLE REPORT AND IS SUBJECT TO THE RESTRICTIONS, COMMENTS, AND/OR EASEMENTS THAT MAY BE CONTAINED THEREIN.
 2. THE PROPERTY LINE SHOWN WAS TAKEN FROM A TITLE REPORT AND IS SUBJECT TO THE RESTRICTIONS, COMMENTS, AND/OR EASEMENTS THAT MAY BE CONTAINED THEREIN.
 3. THE PLAN IS BASED ON THE DATA PROVIDED BY THE CLIENT. THE CLIENT HAS REPRESENTED THAT THE DATA IS TRUE AND CORRECT AND HAS NOT BEEN FIELD VERIFIED. CONTACT US PRIOR TO ANY OCCUPATION.

CERTIFICATION:
 I, THE UNDERSIGNED, AM A LICENSED PROFESSIONAL LAND SURVEYOR IN THE STATE OF RHODE ISLAND AND I HEREBY CERTIFY THAT THE PLAN IS TRUE AND CORRECT AND HAS NOT BEEN FIELD VERIFIED. CONTACT US PRIOR TO ANY OCCUPATION.


STATEMENT OF WORK
 THE PURPOSE OF THIS PLAN IS TO DEPICT THE APPROXIMATE EXISTING CONDITIONS FOR AP 80-2, LOT 14.

BY: MATTHEW J. DOTY
 PLS-1977
 COL. 15.00045

DATE: 11/1/13
 SCALE: 1" = 30'

THIS PLAN IS TO BE INDEXED UNDER THE FOLLOWING ROADS:
 1. WISE POND ROAD
 2. COMMODORE OLIVER HAZARD PERRY HWY

Scale 1" = 30'
 0 30 60 90

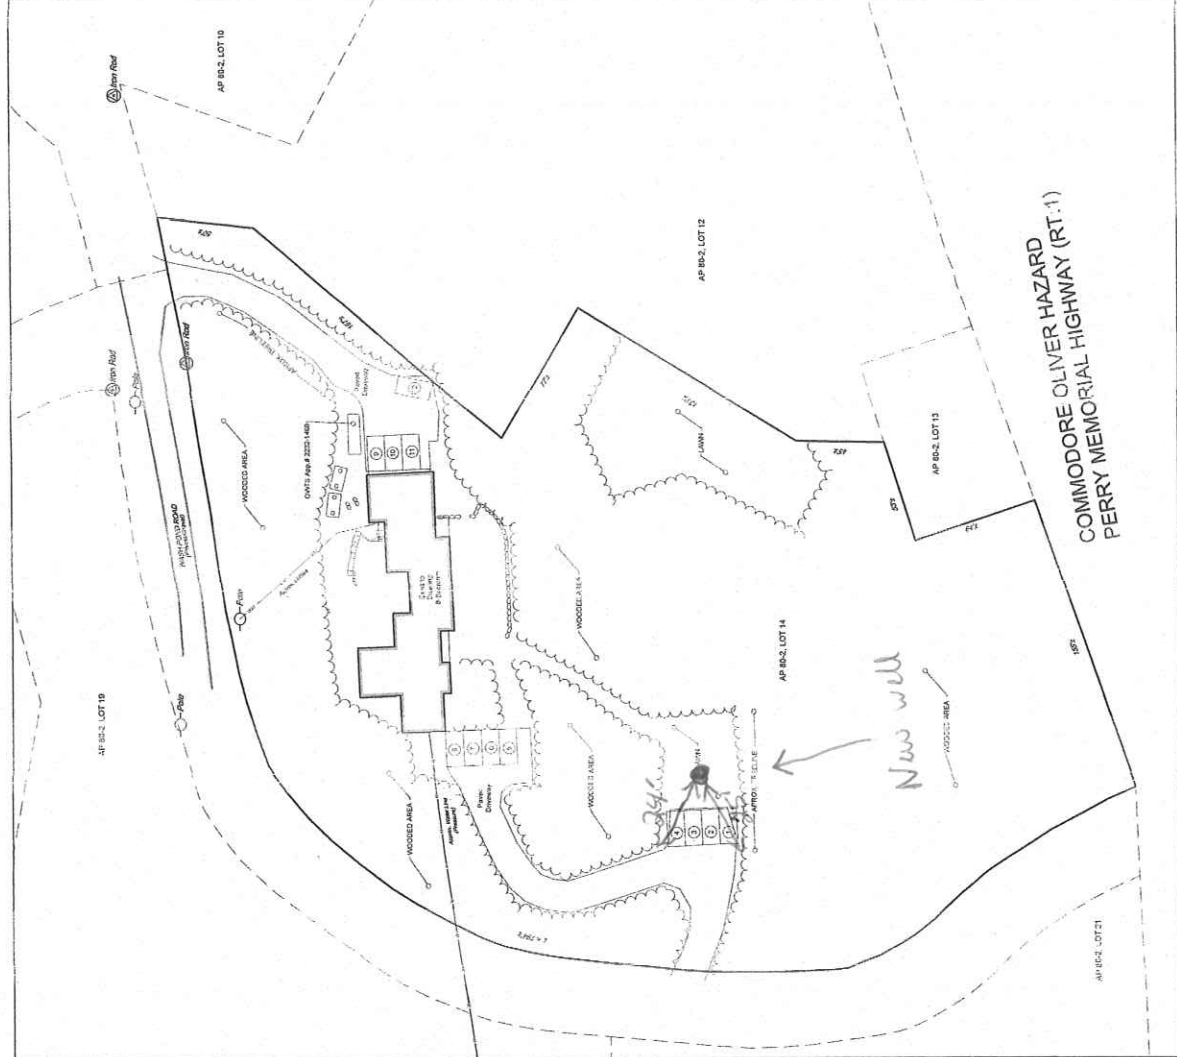


COMMODORE OLIVER HAZARD
 PERRY MEMORIAL HIGHWAY (RT. 1)

FOR
 SITE PLAN
 COMMODORE MANOR, LLC.
 LOCATED AT
 2625B COMM. OLIVER HAZARD PERRY HWY
 SOUTH KINGSTOWN, RI

NO.	REVISIONS	DATE
1	Final Drawing	11/1/2013

Scale: 1" = 30'
 Date: 11/1/2013
 Drawn By: ADM
 Checked By: MIC

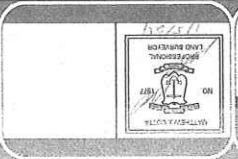

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 Professional Engineering & Land Surveying
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 Exeter, Rhode Island 02822
 DCotto@AmericanEngineeringRI.com
 Phone (401) 294-4090 / Fax (401) 294-3625

Sheet
 of 1 sheets
 Drawing No. 122210